

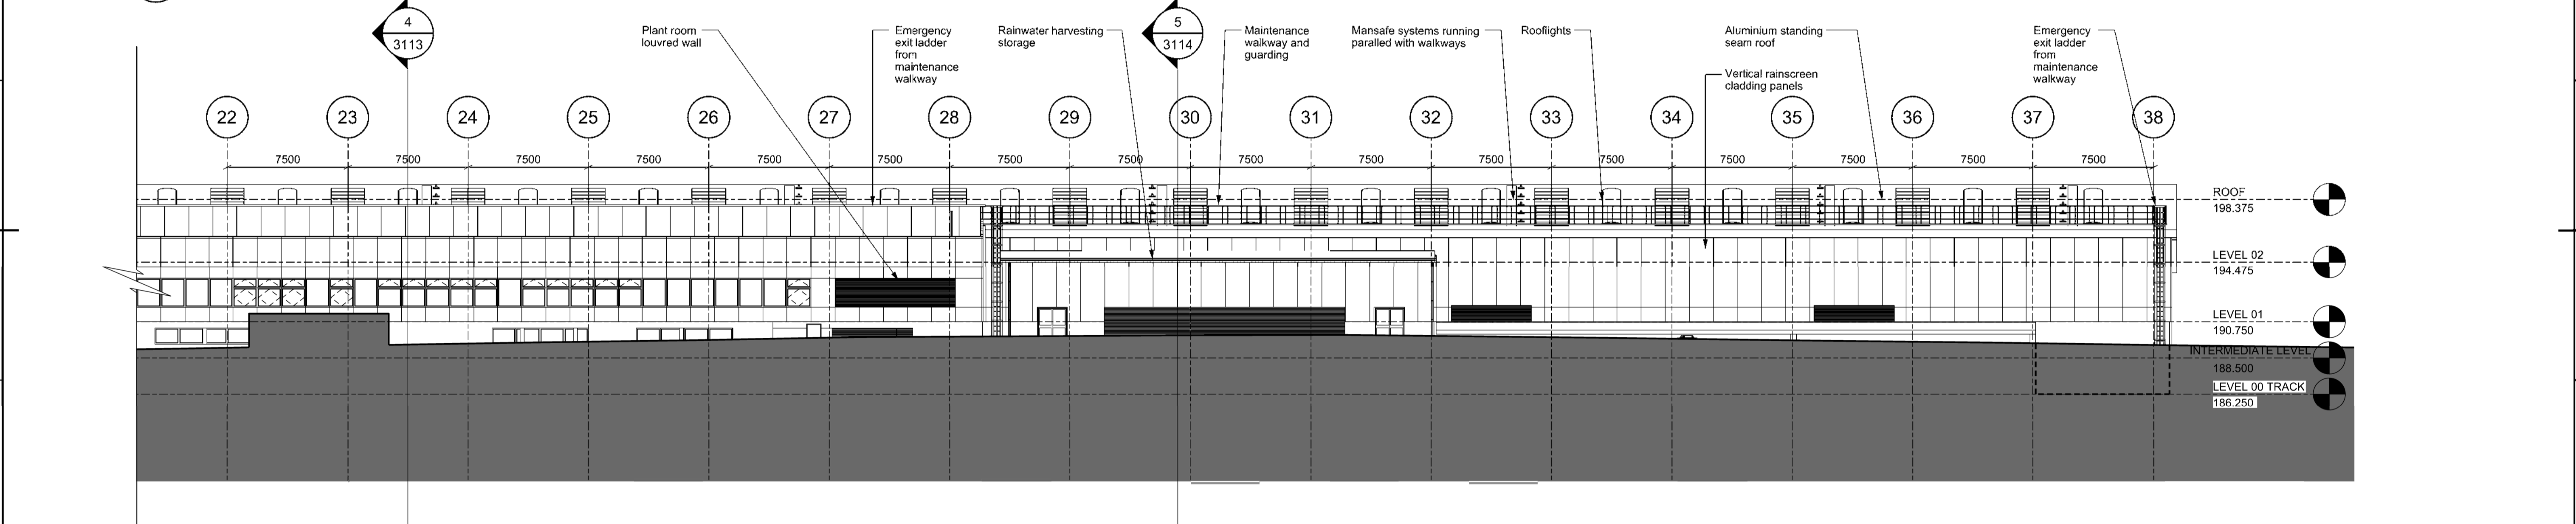


C South Elevation GL 1 to GL 20a
 Scale 1:200

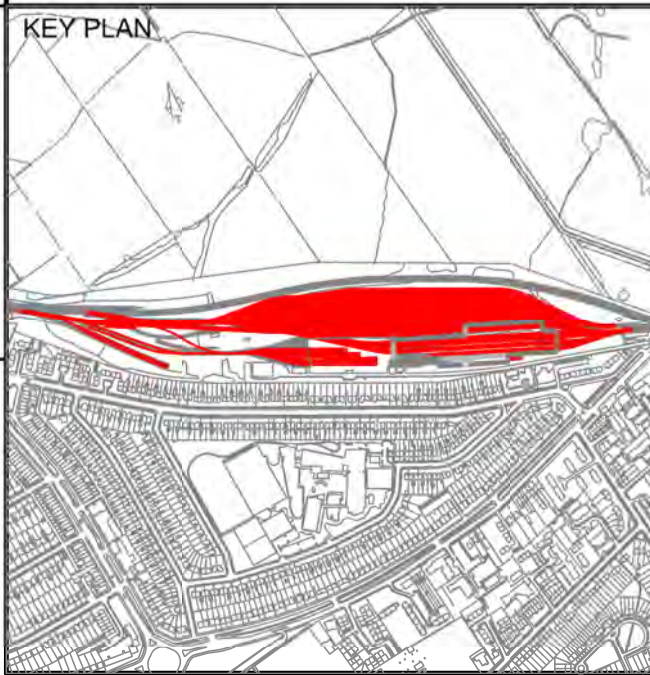

C South Elevation GL 19 to GL 38
 Scale 1:200

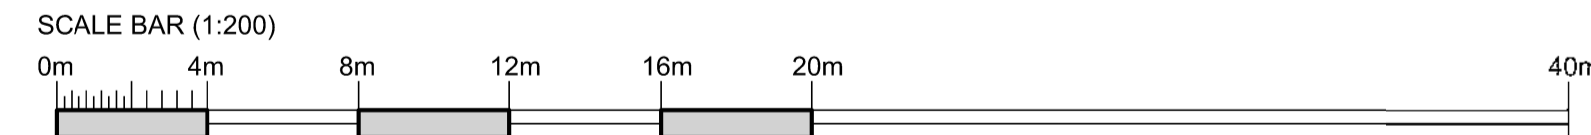

<ol style="list-style-type: none"> Segregate construction activities from pedestrians & adjacent live rails. Existing services within vicinity of works. Isolate / protect all buried services prior to works. Safety measures for excavations, working at height, traffic areas & proximity to live rail. Existing embankment, precautions required during excavation. 	<ol style="list-style-type: none"> Falling from height. Existing services within vicinity of works. 	<ol style="list-style-type: none"> Falling from height. Risk of asbestos. Risk of lead content & possibility of other toxic substances in existing paint finishes. Existing live services within vicinity of works. Safety measures for working in close proximity to live rail.
CONSTRUCTION RISKS	MAINTENANCE / CLEANING RISKS	DEMOLITION / ADAPTATION RISKS

In addition to the hazards risks normally associated with the type of works detailed on this drawing take note of the above. It is assumed that all works on this drawing will be carried out by a competent contractor working where appropriate, to an appropriate method statement.

SAFETY HEALTH AND ENVIRONMENTAL INFORMATION BOX

NOTES:

- Do not scale from this drawing.
- This drawing is for town planning purposes only. Drawing to be printed in colour.
- Refer to Premises drawings:
 - DTUP-JEG-PRM-PD012_1-DR-W-1110 - Maintenance Shed as Proposed Ground Track Level
 - DTUP-JEG-PRM-PD012_1-DR-W-1111 - Maintenance Shed as Proposed Ground Track Level Sheet 1 of 2
 - DTUP-JEG-PRM-PD012_1-DR-W-1112 - Maintenance Shed as Proposed Ground Track Level Sheet 2 of 2
 - DTUP-JEG-PRM-PD012_A-DR-W-1210 - Maintenance Shed as Proposed First Floor Level
 - DTUP-JEG-PRM-PD012_A-DR-W-1211 - Maintenance Shed as Proposed First Floor Level Sheet 1 of 2
 - DTUP-JEG-PRM-PD012_A-DR-W-1212 - Maintenance Shed as Proposed First Floor Level Sheet 2 of 2
 - DTUP-JEG-PRM-PD012_1-DR-W-1011 - Location Plan as Proposed
 - DTUP-JEG-PRM-PD012_1-DR-W-1012 - Existing Site Plan
 - DTUP-JEG-PRM-PD012_1-DR-W-1013 - Site Plan as Proposed
 - DTUP-JEG-PRM-PD012_1-DR-W-1014 - Walkway routes & car parking

DTUP-JEG-PRM-PD012_Z-DR-W-1120 - Accommodation Block Ground and Floor level as proposed
 DTUP-JEG-PRM-PD012_Z-DR-W-1130 - Reflected Ceiling plan layout Ground and Floor level as proposed
 DTUP-JEG-PRM-PD012_B-DR-W-1310 - Maintenance Shed proposed building layout accommodation roof level
 DTUP-JEG-PRM-PD012_B-DR-W-1311 - Maintenance Shed as proposed shed roof level sheet 1 of 3
 DTUP-JEG-PRM-PD012_B-DR-W-1312 - Maintenance Shed as proposed shed roof level sheet 2 of 3
 DTUP-JEG-PRM-PD012_B-DR-W-1313 - Maintenance Shed as proposed shed roof level sheet 3 of 3
 DTUP-JEG-PRM-PD012_B-DR-W-1314 - Maintenance Shed access and escape proposed building layout shed roof level
 DTUP-JEG-PRM-PD012_Z-DR-W-2110 - Maintenance Shed as Proposed Elevations
 DTUP-JEG-PRM-PD012_Z-DR-W-2111 - Maintenance Shed as Proposed Elevations
 DTUP-JEG-PRM-PD012_Z-DR-W-3110 - Maintenance Shed as Proposed Long Section
 DTUP-JEG-PRM-PD012_Z-DR-W-3111 - Maintenance Shed as Proposed Long Section
 DTUP-JEG-PRM-PD012_Z-DR-W-3112 - Maintenance Shed as Proposed Cross Section
 DTUP-JEG-PRM-PD012_Z-DR-W-3113 - Maintenance Shed as Proposed Cross Section
 DTUP-JEG-PRM-PD012_Z-DR-W-3114 - Maintenance Shed as Proposed Cross Section
 DTUP-JEG-PRM-PD012_1-DR-W-6010 - Demolition Plan
 DTUP-JEG-PRM-PD012_Z-DR-W-8110 - 3D perspective views as proposed
 DTUP-JEG-PRM-PD012_Z-DR-W-8111 - 3D perspective views as proposed
 DTUP-JEG-PRM-PD012_Z-DR-W-8112 - 3D perspective views as proposed depot site

TFL RESTRICTED	CONCEPT DESIGN ISSUE	19/12/18	ZB	19/12/18	MS	19/12/18
	CONCEPT DESIGN ISSUE	06/11/20	ZB	06/11/20	MS	06/11/20
	PURPOSE					
	CREATED BY	DATE	APPROVED BY	DATE	AUTHORISED BY	DATE

PROJECT	DEEP TUBE UPGRADE PROGRAMME
LOCATION	COCKFOSTERS DEPOT
ASSET CLASSIFICATION	PREMISES
OWNER	JACOBS
SUITABILITY CODE	S3
SUITABILITY	FOR COMMENT

TITLE	MAINTENANCE SHED ELEVATIONS
DRAWING NUMBER	DTUP-JEG-PRM-PD012_Z-DR-W-2112
REV.	P02